




TOTAL

75

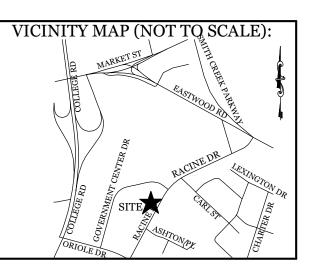

REVISIONS

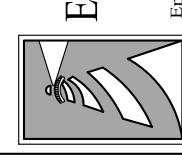

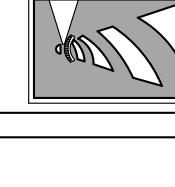



EXISTING CONDITIC TREE REMOVAL & PROTECTION PLA


Scale: 1"=30'

CLIENT INFORMATION: AMANDA CHAPPEL MATT PROPERTIES III, LLC 1908 EASTWOOD ROAD, SUITE 222 WILMINGTON, NC 28403

DRAWN: JAE		SHEET SIZE:	24 X 36
CHECKED:	CDC	DATE:	2/26/2021
APPROVED: CDC		SCALE:	1" = 30'
PROJECT NUMBER:		2020-029	

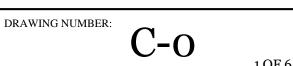


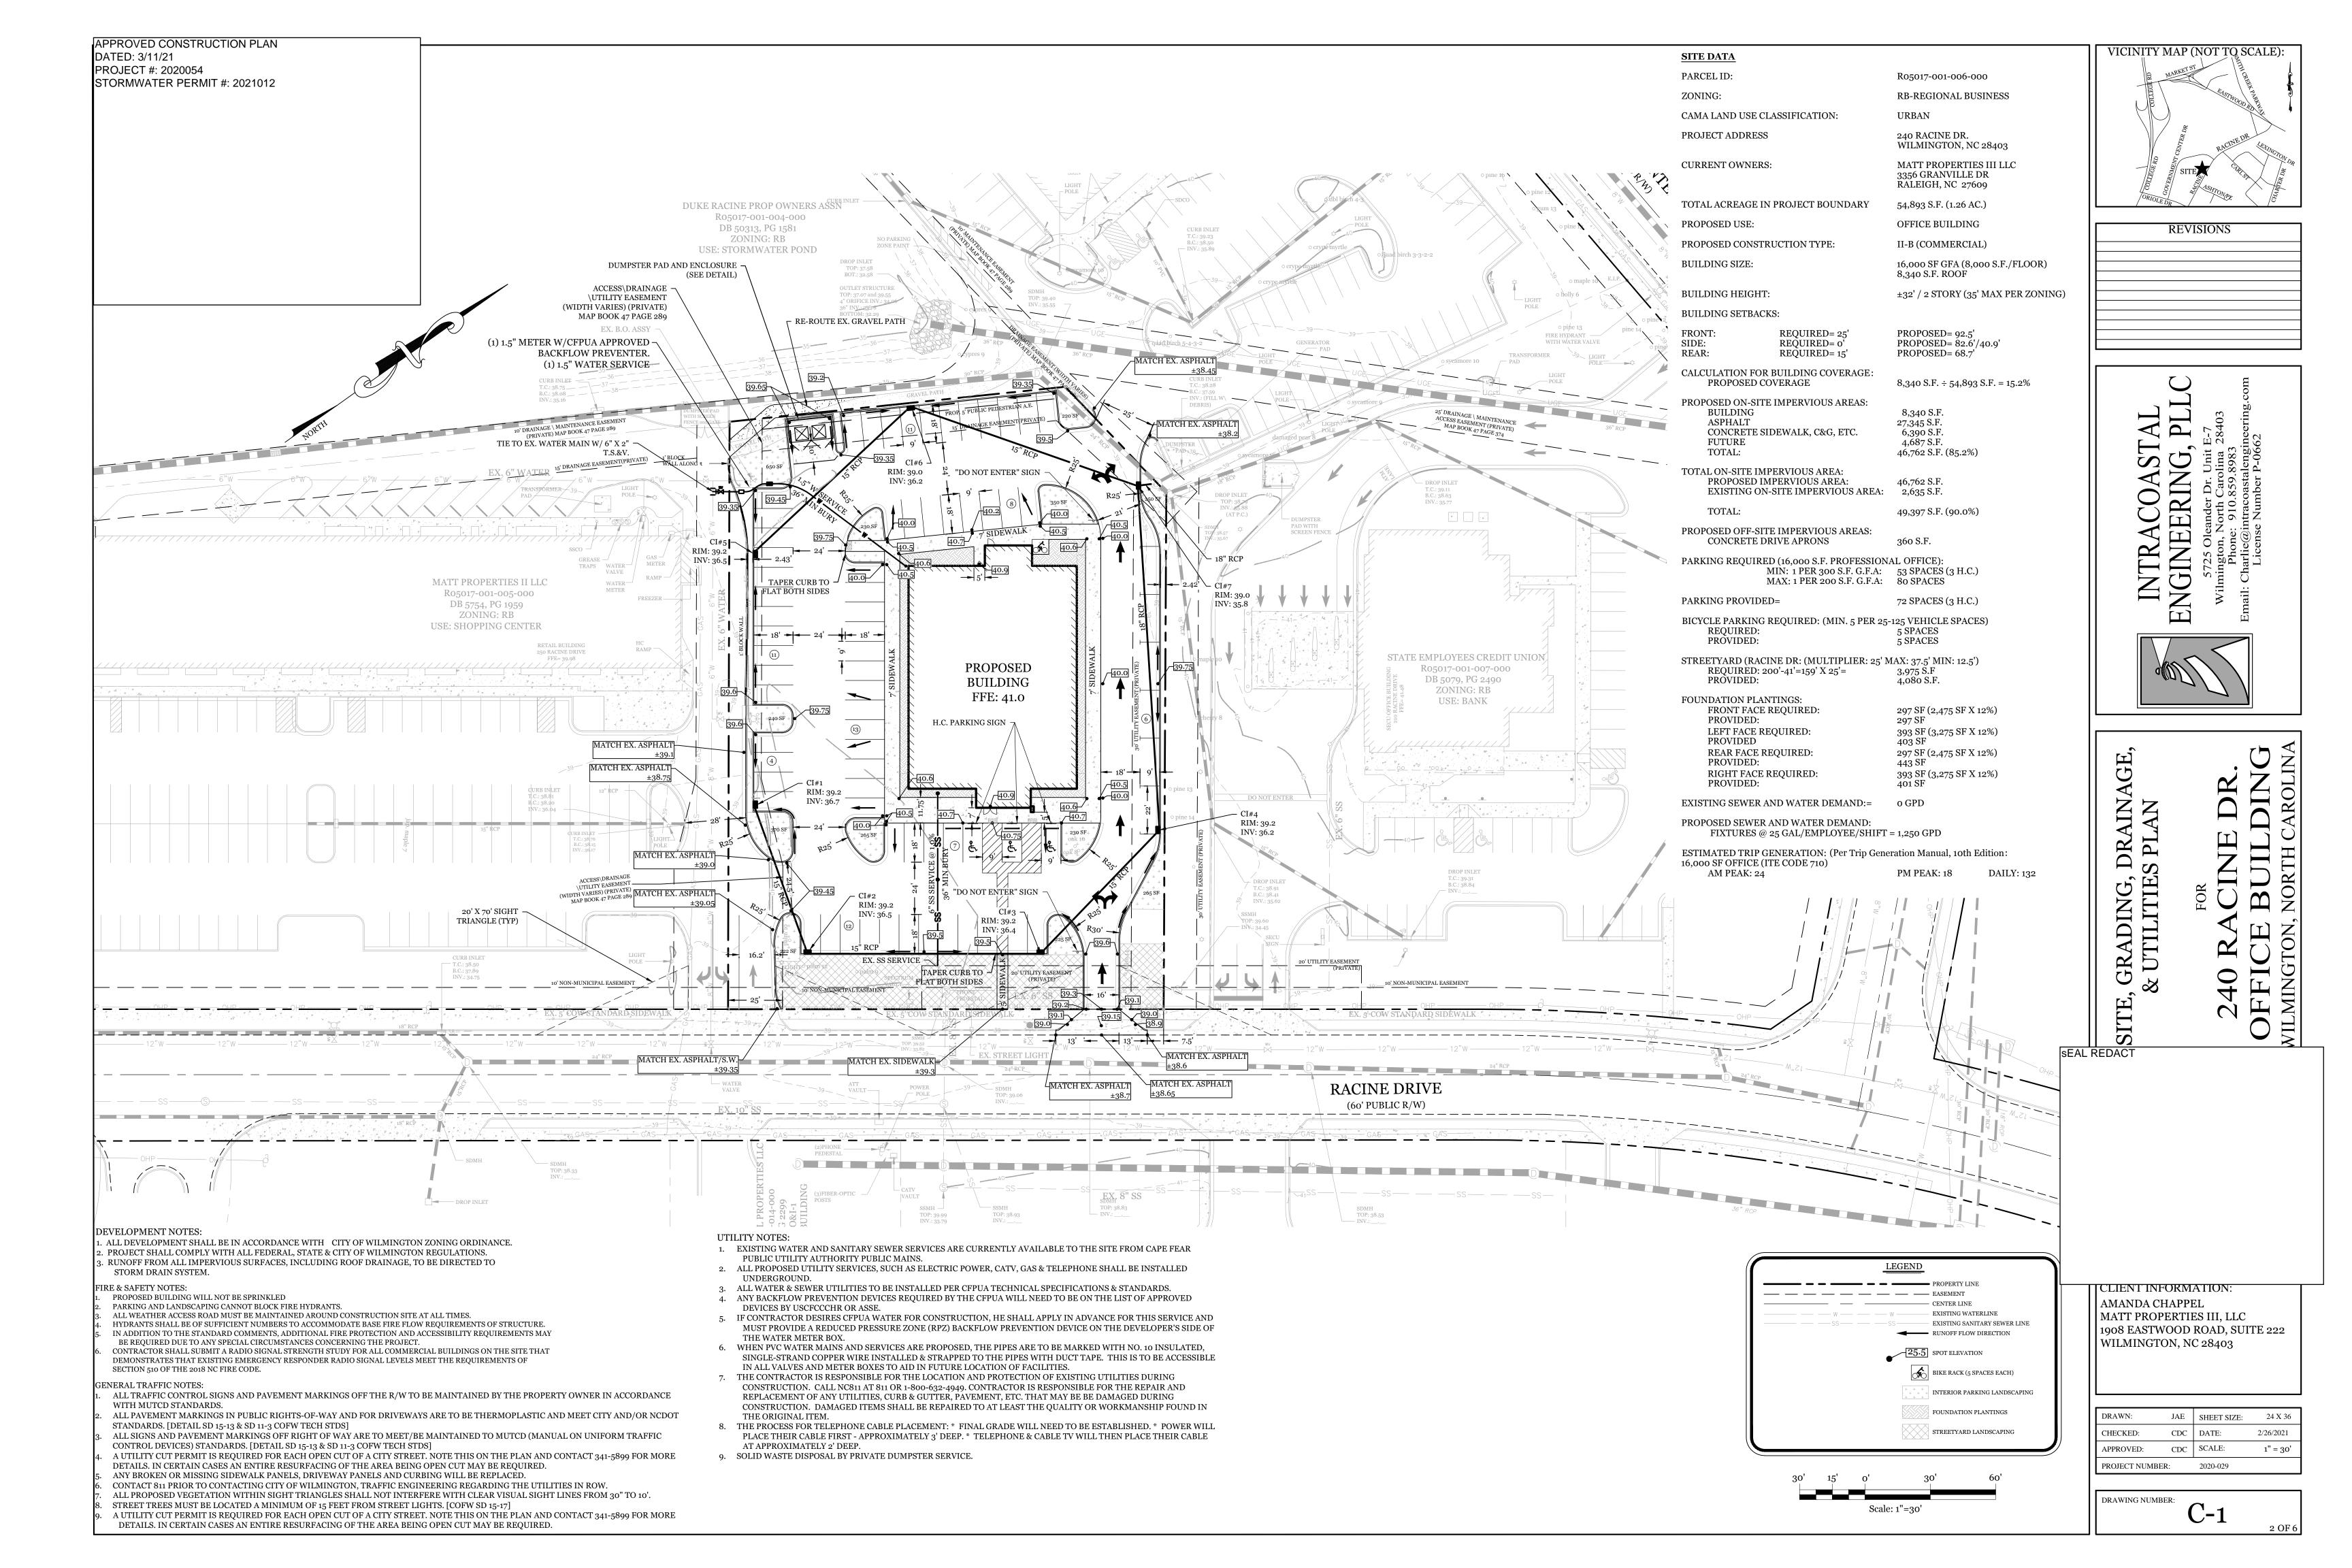

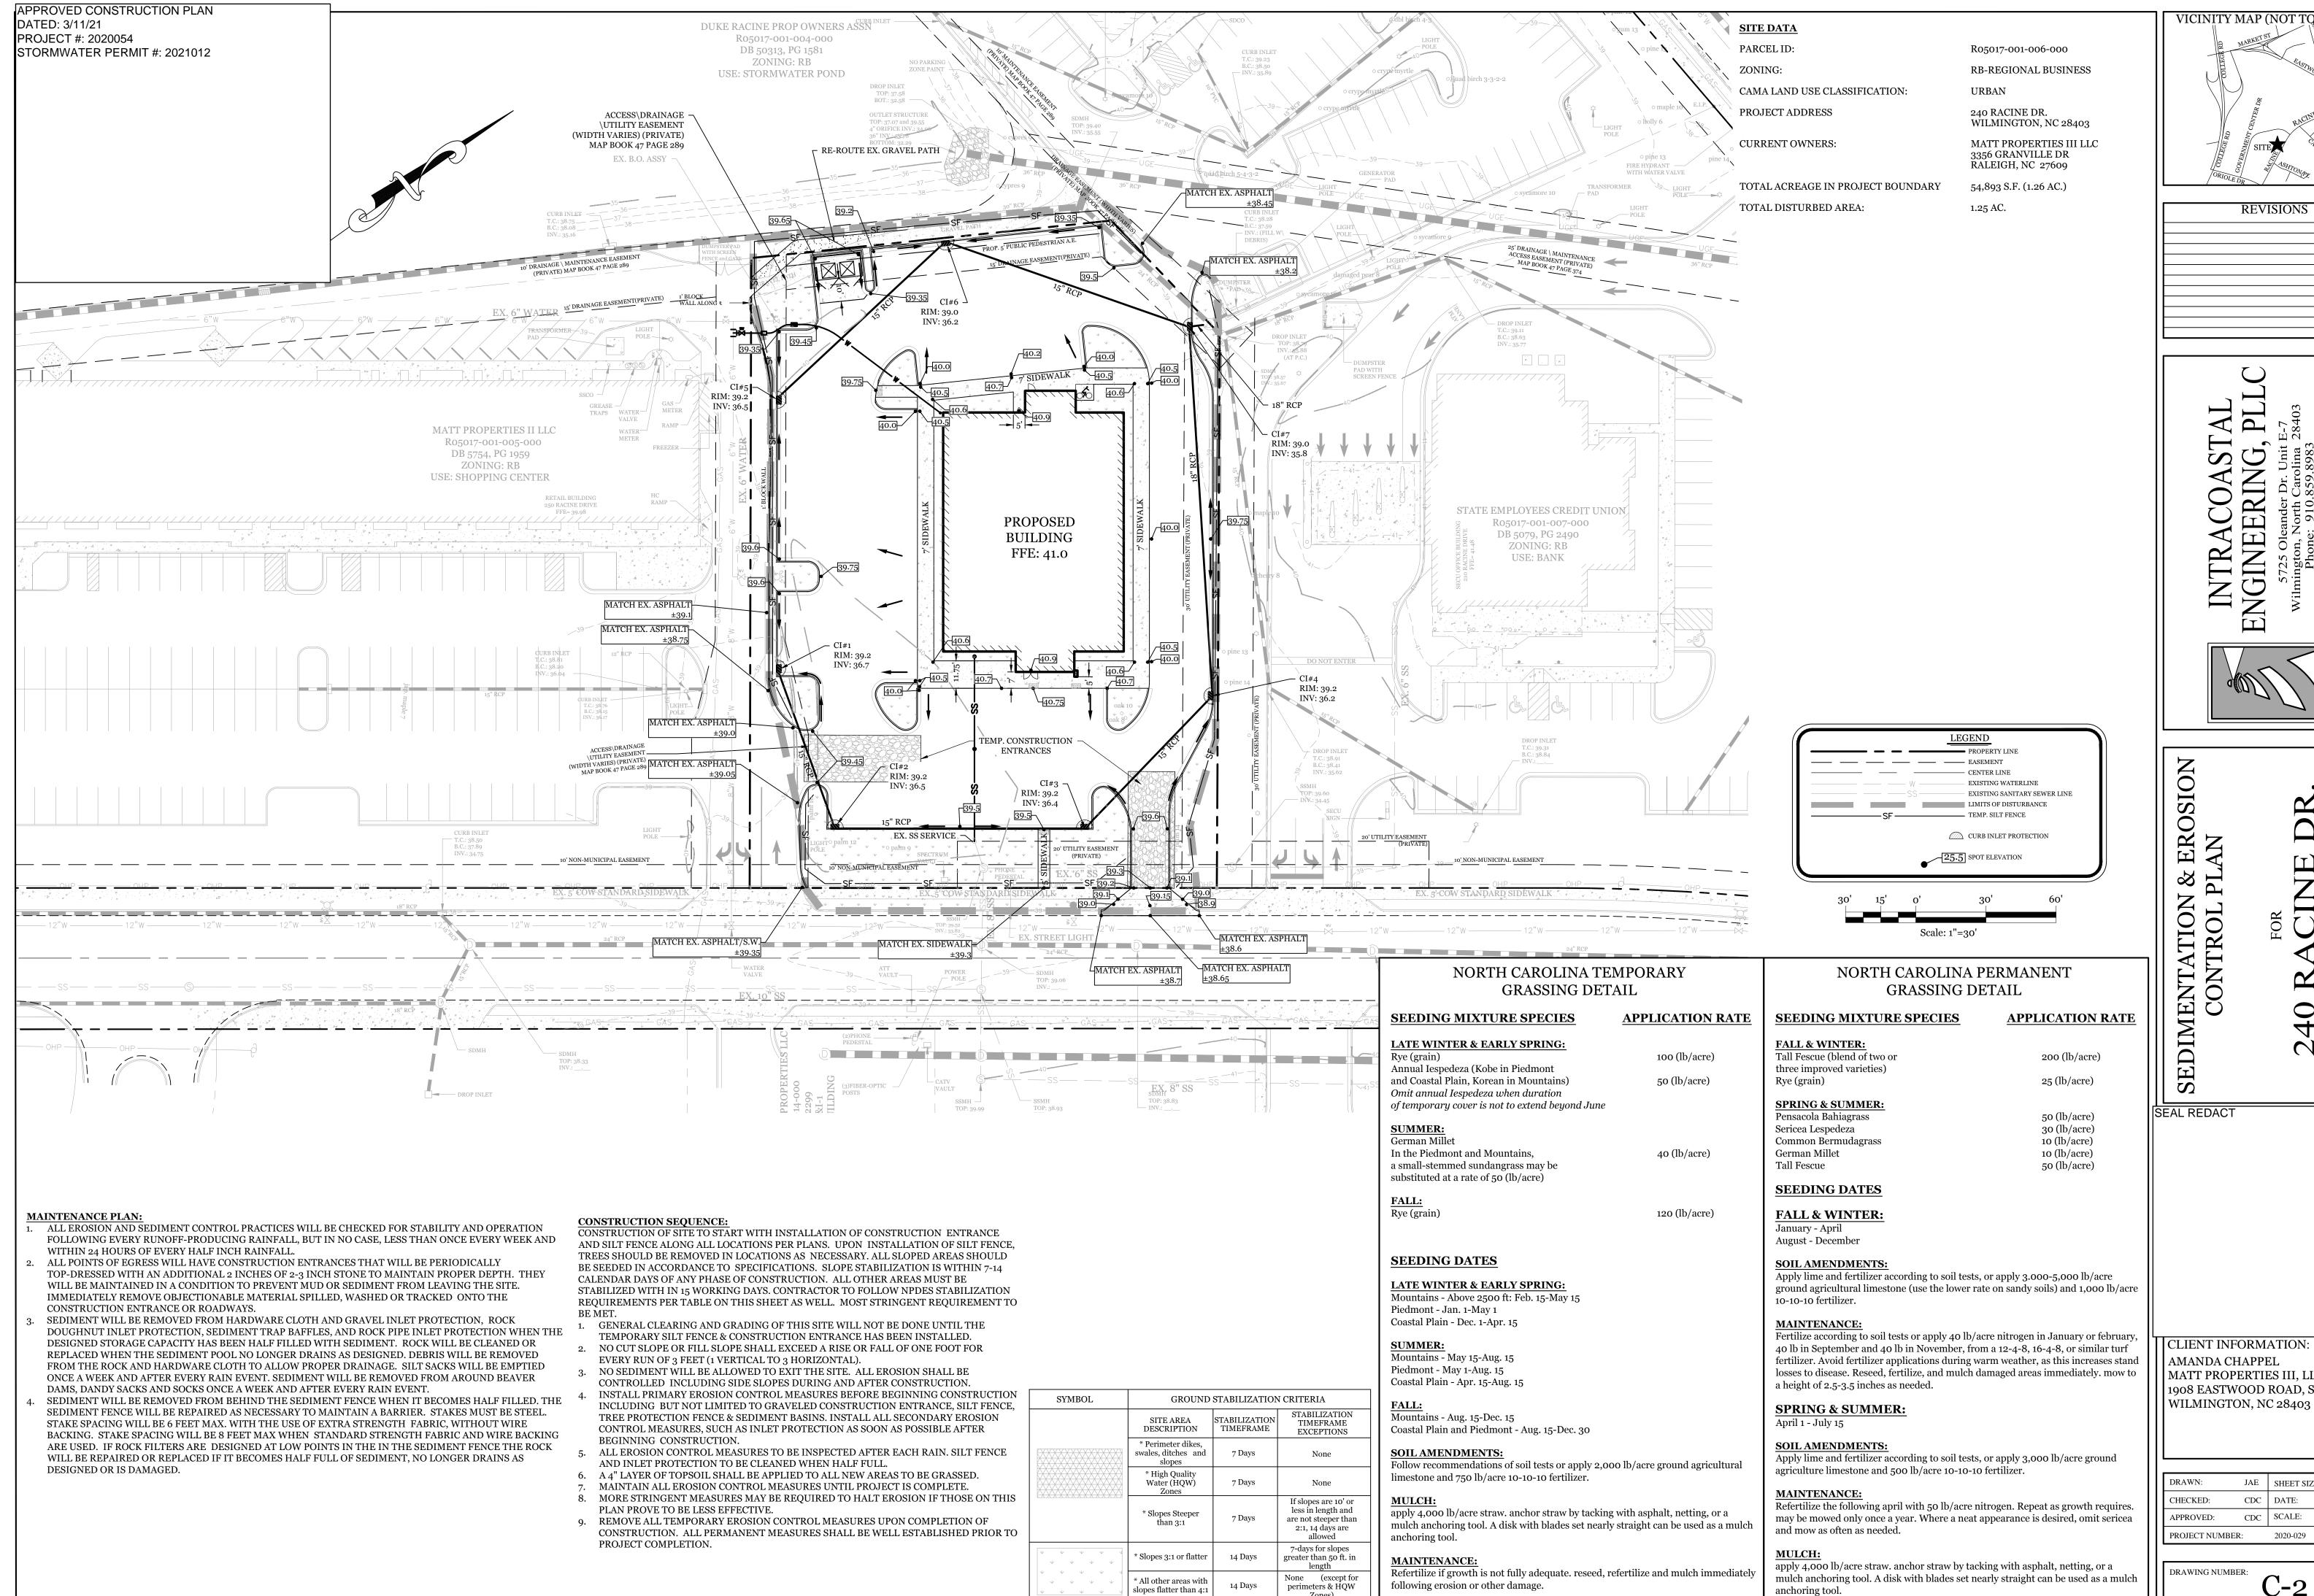

VICINITY MAP (NOT TQ SCALE):

REVISIONS

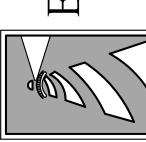



CLIENT INFORMATION: AMANDA CHAPPEL MATT PROPERTIES III, LLC 1908 EASTWOOD ROAD, SUITE 222


DRAWN:	JAE	SHEET SIZE:	24 X 36
CHECKED:	CDC	DATE:	2/26/2021
APPROVED:	CDC	SCALE:	1" = 30'
DD O IE CTE NI II ADI	7.0	2020 020	


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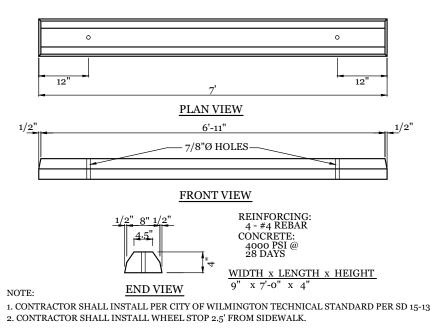




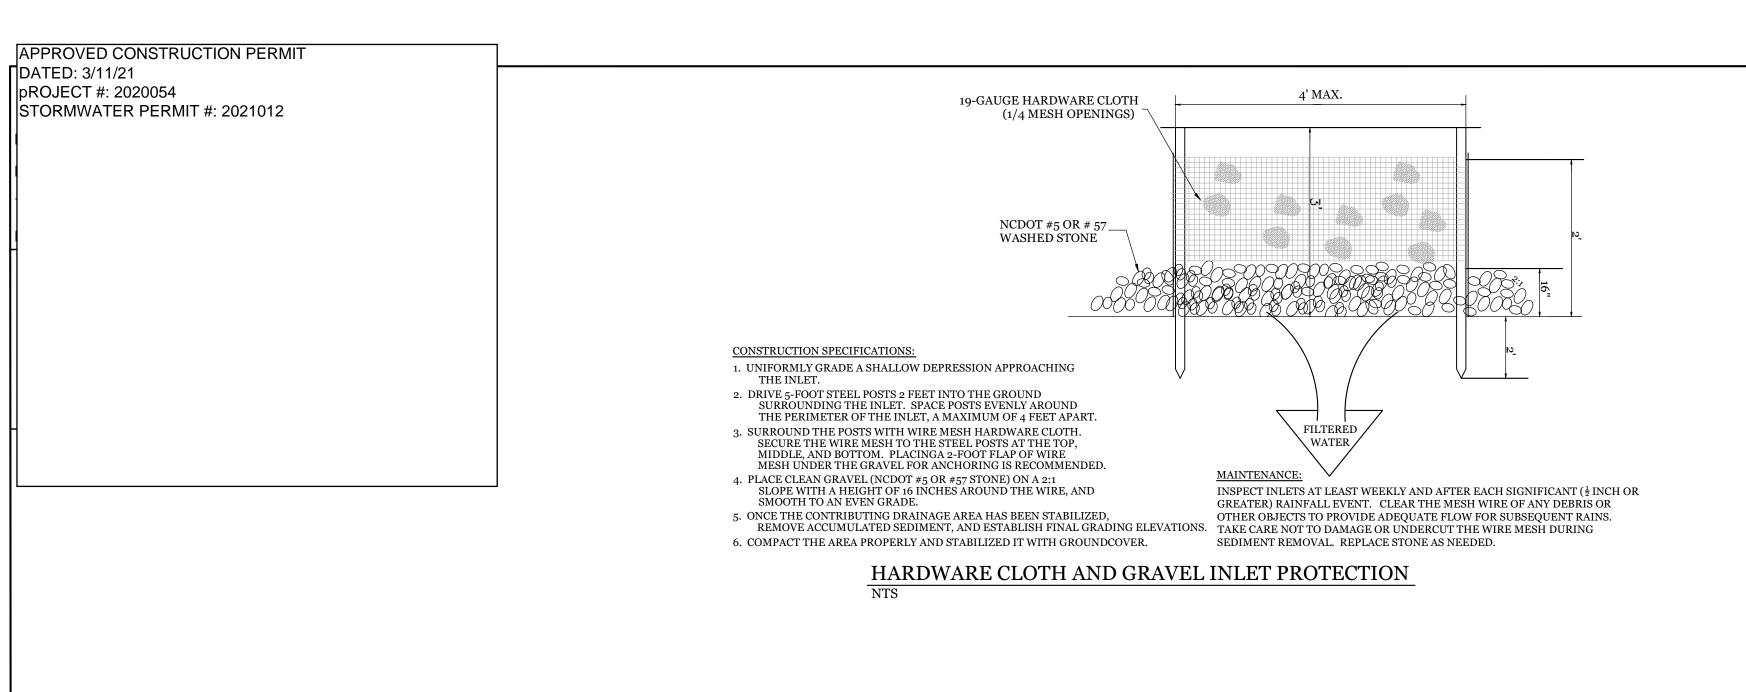


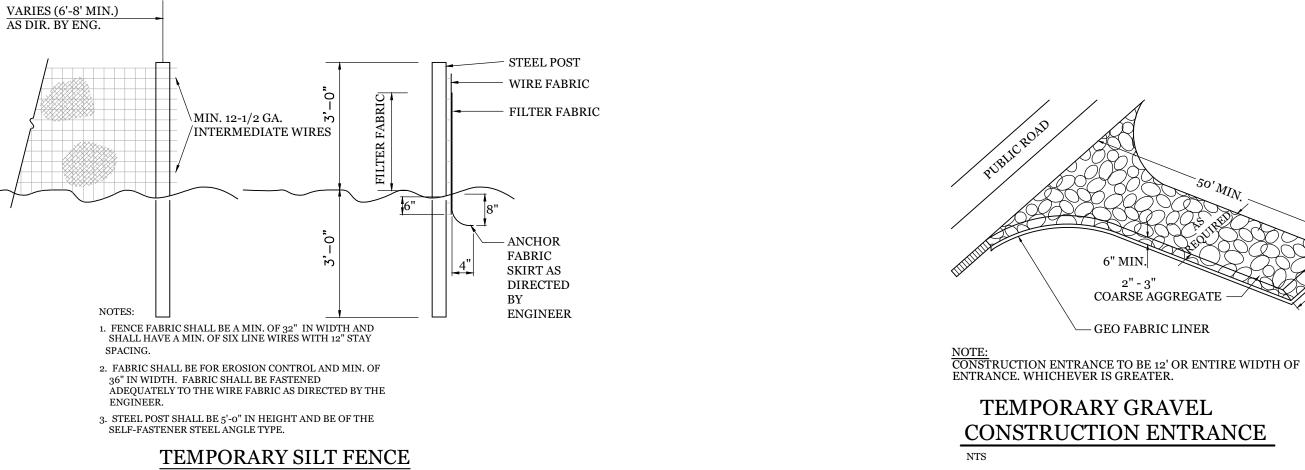

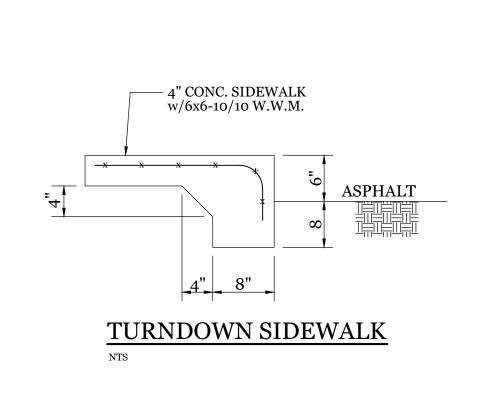

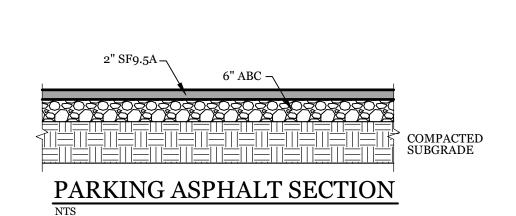




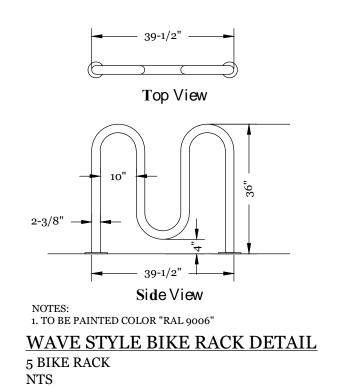



SITE WORK NOTES:

- 1. THE CONTRACTOR SHALL VISIT THE SITE AND BECOME FAMILIAR WITH EXISTING CONDITIONS BOTH ON AND ADJACENT TO THE SITE.
- 2. CLEARING: CONTRACTOR SHALL REMOVE ALL TREES AND VEGETATION WITHIN LIMITS OF CONSTRUCTION UNLESS OTHERWISE DESIGNATED TO REMAIN. GRUBBING AND STRIPPING: CONTRACTOR SHALL RAKE AND REMOVE ROOTS, STUMPS, VEGETATION, DEBRIS, EXISTING STRUCTURES ABOVE AND BELOW GRADE, ORGANIC
- MUCKING: CONTRACTOR SHALL COORDINATE WITH OWNER AND THEIR GEOTECHNICAL REPRESENTATIVE TO COORDINATE REMOVAL OF ANY SOFT AREAS.
- DISPOSAL: CLEARED, GRUBBED, STRIPPED OR OTHER WASTE MATERIAL SHALL BE REMOVED FROM SITE AND DISPOSED OF IN A PROPERLY PERMITTED FACILITY.
- FILL AND COMPACTION SHOULD COMPLY WITH GEOTECHNICAL RECOMMENDATIONS. THE CONTRACTOR SHALL NOTE THAT THE GRADING PLAN MAY NOT REPRESENT A BALANCED EARTHWORK CONDITION. THE CONTRACTOR SHALL BE RESPONSIBLE FOR
- CUT AND FILL QUANTITIES AND COMPLETE INSTALLATION TO SPECIFIED GRADES. 8. THE CONTRACTOR SHALL FURNISH SUITABLE BORROW MATERIAL FROM AN OFF-SITE PROPERLY PERMITTED FACILITY AS REQUIRED
- CLEARANCES ARE LESS THAN INDICATED ON PLAN, THE CONTRACTOR SHALL CONTACT THE DESIGN ENGINEER BEFORE PROCEEDING WITH CONSTRUCTION, ANY BEFORE PROCEEDING WITH CONSTRUCTION.
- 10. NO CONSTRUCTION IS TO BEGIN BEFORE LOCATION OF EXISTING UTILITIES HAS BEEN DETERMINED. CALL "NC ONE-CALL" AT LEAST 48 HOURS BEFORE COMMENCING
- 11. THE CONTRACTOR IS RESPONSIBLE FOR THE LOCATION AND PROTECTION OF ALL EXISTING UTILITIES DURING CONSTRUCTION. BEFORE COMMENCING ANY EXCAVATIONS IN OR ALONG ROADWAYS OR RIGHT-OF-WAYS, PUBLIC AREAS OR IN PRIVATE EASEMENTS, THE CONTRACTOR SHALL NOTIFY ALL APPROPRIATE PERSONNEL OF THEIR INTENT TO EXCAVATE, IN WRITING, NOT LESS THAN 10 DAYS PRIOR TO EXCAVATING.
- 12. THE CONTRACTOR SHALL BE RESPONSIBLE TO COORDINATE DISCONNECTION/ RECONNECTION AND/OR THE RELOCATION OF ALL EXISTING UTILITIES WITH APPROPRIATE 13. CONTRACTOR SHALL ADJUST ALL MANHOLES, VALVE & CURB BOXES TO FINAL GRADE UPON COMPLETION OF ALL CONSTRUCTION. ANY BOXES DAMAGED OR OTHERWISE
- DISTURBED BY THE CONTRACTOR SHALL BE REPAIRED AT THE EXPENSE OF THE CONTRACTOR. 14. THE CONTRACTOR SHALL FIELD VERIFY ALL DIMENSIONS AT THE SITE. FURTHERMORE THE CONTRACTOR SHALL REPORT ALL DISCREPANCIES OR QUESTIONS TO THE
- ENGINEER PRIOR TO INSTALLATION.
- 15. THE CONTRACTOR SHALL PROVIDE ANY AND ALL LAYOUT REQUIRED TO CONSTRUCT HIS WORK UNLESS OTHERWISE DIRECTED BY OWNER. 16. ALL SERVICE CONNECTIONS SHALL BE INSTALLED TO MEET ALL LOCAL, STATE, AND CFPUA CODES. METERS, TAPS, MATERIALS, WORKMANSHIP AND ALL FEES SHALL BE THE RESPONSIBILITY OF THE CONTRACTOR AND SHALL COMPLY WITH ALL REQUIREMENTS.
- AT CONTRACTORS COST AS NECESSARY. 18. ALL AREAS SHALL BE GRADED FOR POSITIVE DRAINAGE. CONTRACTOR SHALL REPORT ANY DISCREPANCIES TO THE ENGINEER PRIOR TO INSTALLATION. ALL AREAS
- SHALL BE SLOPED TO DRAIN AWAY FROM BUILDINGS AT ALL TIMES. 19. CONCRETE FOR WALKS, CURBS AND DRIVES SHALL HAVE A MINIMUM COMPRESSIVE STRENGTH OF 3000 PSI @ 28 DAYS - AIR ENTRAINED
- 20. FIELD TESTING SHALL BE DONE BY AN INDEPENDENT TESTING LABORATORY PAID FOR BY THE OWNER. FURTHER TESTING REQUIRED DUE TO A FAILED TEST WILL BE PAID FOR BY THE CONTRACTOR.



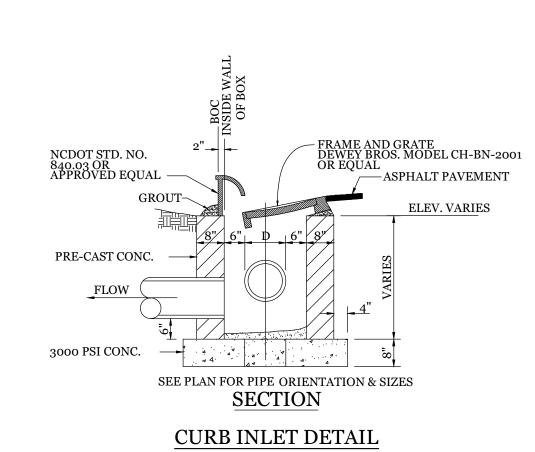

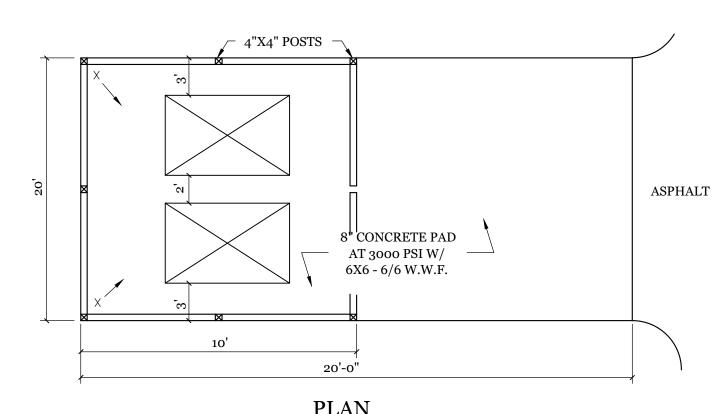


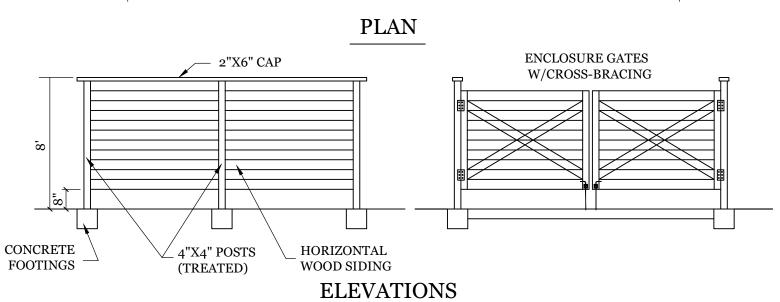


DUMPSTER PAD & ENCLOSURE DETAIL

REVISIONS

VICINITY MAP (NOT TQ SCALE):

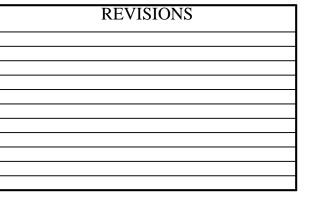



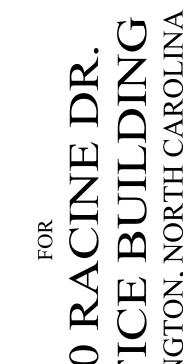


SEAL REDACT

CLIENT INFORMATION: AMANDA CHAPPEL MATT PROPERTIES III, LLC 1908 EASTWOOD ROAD, SUITE 222 WILMINGTON, NC 28403

JAE SHEET SIZE: 24 X 36 CDC DATE: 2/26/2021 CDC | SCALE: NTS PROJECT NUMBER: 2020-029

DRAWING NUMBER:

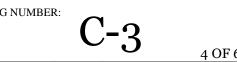

∠ R=1.5°

SECTION A-A

WARNING DOMES

WARNING DOME NOTES: 1. USE CONTRASTING COLORS, RED OR BLACK ON WHITE PAVEMENT. 2. USE CAST IN PLACE PAVERS FOR NEW CONSTRUCTION.

STANDARD DETAIL

PERPENDICULAR CURB

RAMP

ADJACENT TO PLAZA

3. RUBBER MATS ARE PERMITTED FOR RETROFITS.

4. LANDING AND RAMP WIDTH MAY BE REDUCED TO 3' WHERE SPACE

IS LIMITED AND DESIGN IS APPROVED BY THE CITY ENGINEER.

1.5±0.5% 1.0-8.3% (30"MAX RISE)

MIN. LANDING WIDTH = RAMP WIDTH

MAX SLOPE 2% IN ANY DIRECTION

1.6-2.4" (TYP)

WARNING

DOMES

CURB AND GUTTER


WARNING

DRAWN: PB/JSR

CHECKED: DEC

SCALE NOT TO SCALE

DOMES

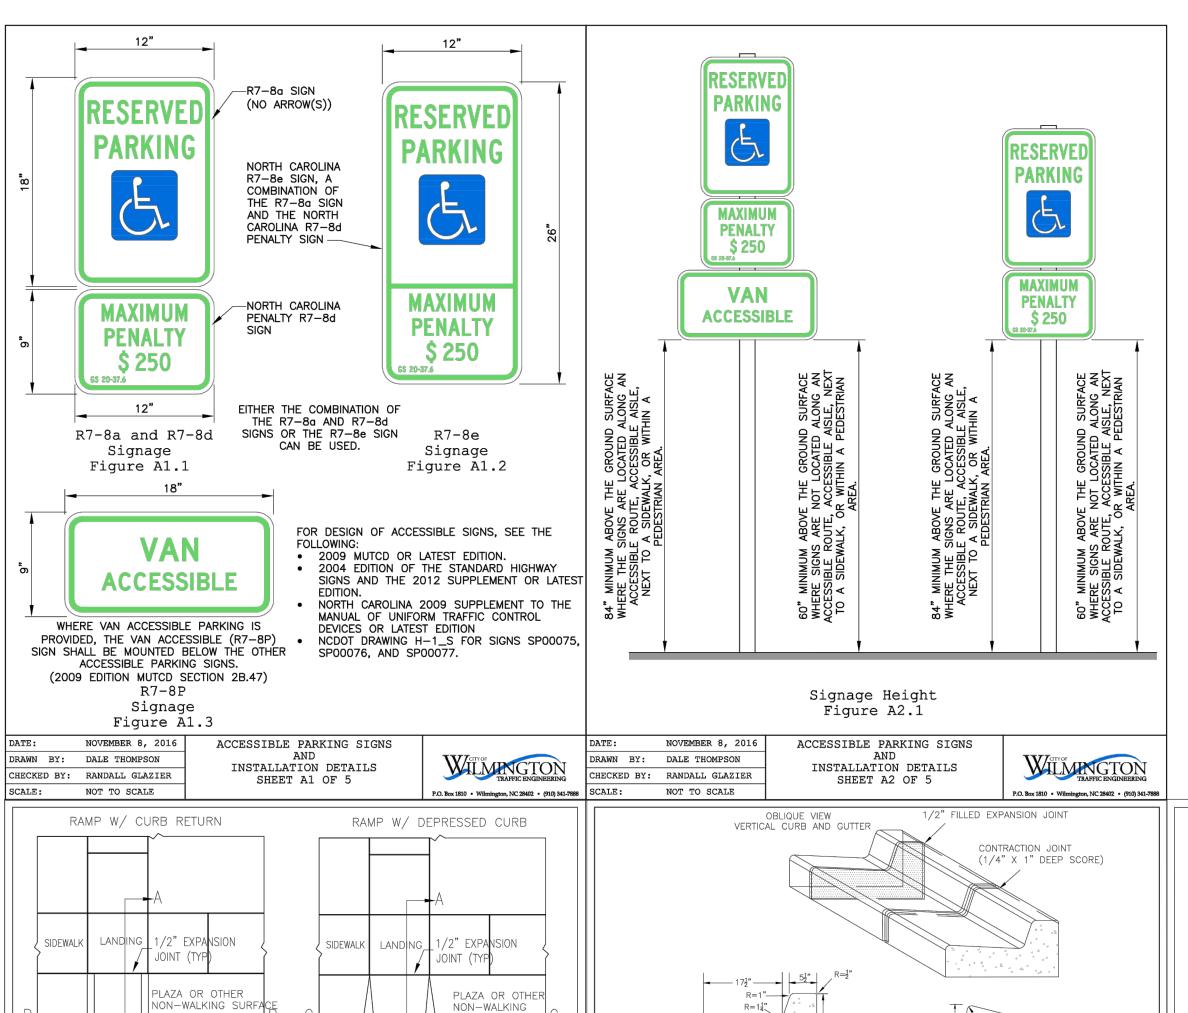

SURFACE

└─A ROUNDED CONCRETE

DEPRESSE

SURFACE

SECTION C-C CURB

TRUNCATED DOMES

OF BASE (TYP)


CITY OF WILMINGTON ENGINEERING PO BOX 1810 WILMINGTON N.C. 28402

SD3-08

BASE DIAMETER 0.9-1.4" TOP DIAMETER 50-60%

4' min SECTION B-B

→ | ~ 2'

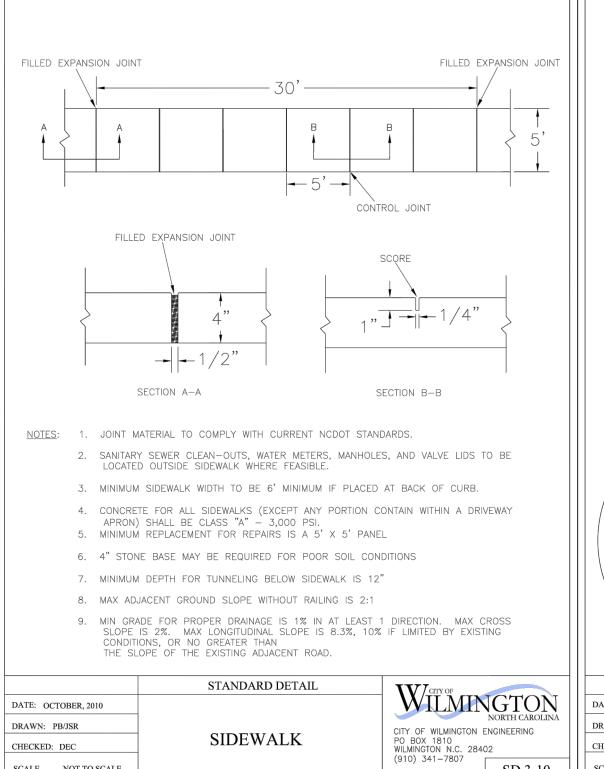

SIDEWALK

SD 3-10

SCALE NOT TO SCALE

12" - 24" -

-12"-- AGGREGATE BASE COURSE

HEADER CURB

SLOPE CURB

GRANITE CURB

CITY OF WILMINGTON ENGINEERING PO BOX 1810 WILMINGTON N.C. 28402 (910) 341-7807

SD 3-11

CHECKED: DEC

SCALE NOT TO SCALE

VERTICAL CURB AND GUTTER

MEDIAN VERTICAL CURB AND GUTTER

DATE: AUGUST, 2011

SCALE NOT TO SCALE

DRAWN: PB/JSR

CHECKED: DEC

24" 12" AGGREGATE 6"-6"-

NOTES: 1. EXPANSION JOINT MATERIAL TO COMPLY WITH CURRENT NCDOT STANDARDS

STANDARD DETAIL

CURBING


2. 50' MAX EXPANSION JOINT SPACING, 10' MAX CONTRACTION JOINT SPACING


4. CONCRETE TO BE 3000 PSI MIN 5. VERTICAL CURB AND GUTTER BASE CAN BE SLOPED 3/4" OR USE A FLAT BASE

VALLEY CURB

3. MINIMUM INSTALLATION LENGTH IS 5 FT.

VERTICAL CURB

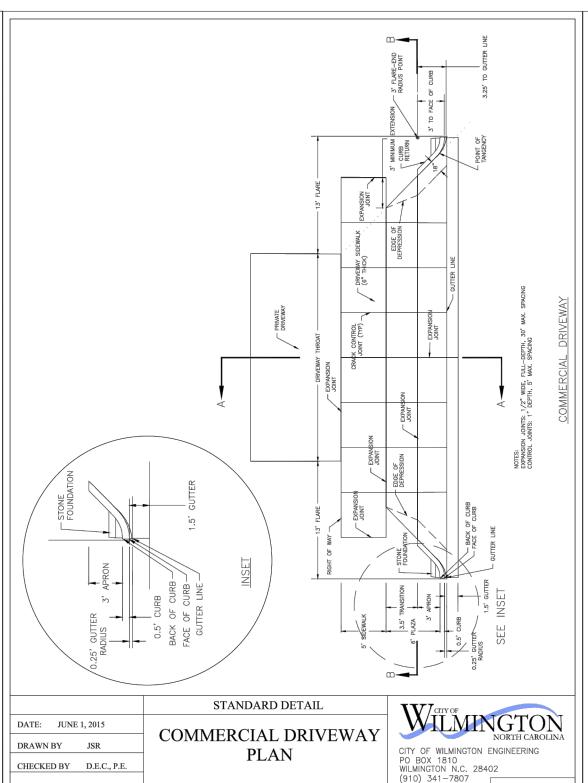

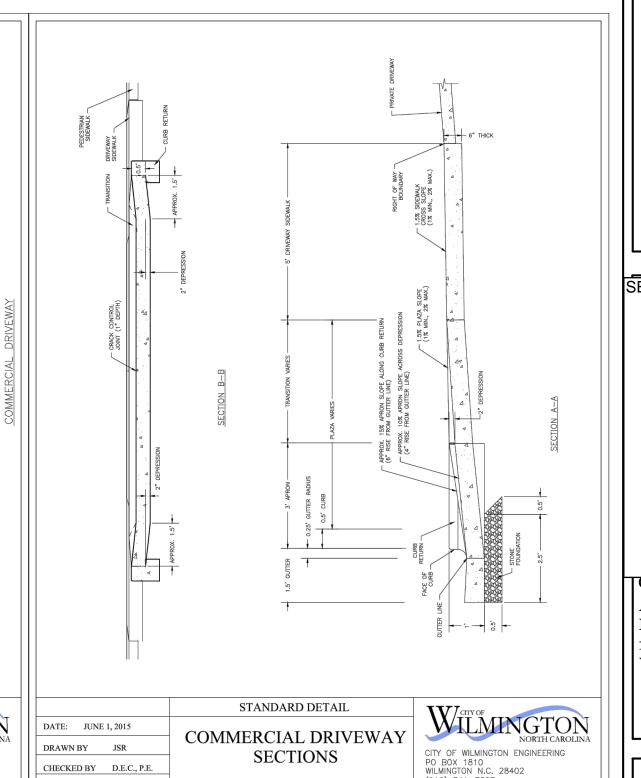

SECTIONS


(910) 341-7807

SD 3-03.4

CHECKED BY D.E.C., P.E.

SCALE NOT TO SCALE

SD 3-03.3

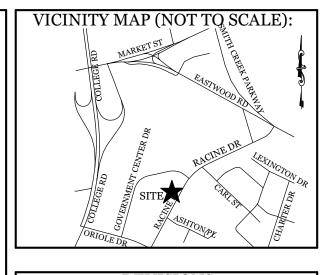

REVISIONS

ALPL

INTRACOAS

H

SEAL REDACT

CLIENT INFORMATION: AMANDA CHAPPEL MATT PROPERTIES III, LLC 1908 EASTWOOD ROAD, SUITE 222 WILMINGTON, NC 28403

l				
	DRAWN:	JAE	SHEET SIZE:	24 X 36
	CHECKED:	CDC	DATE:	2/26/2021
	APPROVED:	CDC	SCALE:	NTS
l	PROJECT NUMBE	R:	2020-029	

DRAWING NUMBER:



PROPOSED OFF-SITE IMPERVIOUS AREAS: CONCRETE DRIVE APRONS PARKING PROVIDED=

R05017-001-006-000

240 RACINE DR.

URBAN

RB-REGIONAL BUSINESS

WILMINGTON, NC 28403

MATT PROPERTIES III LLC

54,893 S.F. (1.26 AC.) x 15 =

19 trees 2" cal. req'd. & prov'd.

16,000 SF GFA (8,000 S.F./FLOOR)

±32' / 2 STORY (35' MAX PER ZONING)

3356 GRANVILLE DR

RALEIGH, NC 27609

OFFICE BUILDING

8,340 S.F. ROOF

PROPOSED= 92.5'

PROPOSED= 68.7'

8,340 S.F.

6,390 S.F.

4,687 S.F.

46,762 S.F.

2,635 S.F.

46,762 S.F. (85.2%)

49,397 S.F. (90.0%)

27,345 S.F.

PROPOSED= 82.6'/40.9'

 $8,340 \text{ S.F.} \div 54,893 \text{ S.F.} = 15.2\%$

II-B (COMMERCIAL)

PARKING REQUIRED (16,000 S.F. PROFESSIONAL OFFICE): MIN: 1 PER 300 S.F. G.F.A: 53 SPACES (3 H.C.) MAX: 1 PER 200 S.F. G.F.A: 80 SPACES

360 S.F.

72 SPACES (3 H.C.)

BICYCLE PARKING REQUIRED: (MIN. 5 PER 25-125 VEHICLE SPACES) REQUIRED: PROVIDED: 5 SPACES

STREETYARD (RACINE DR: (MULTIPLIER: 25' MAX: 37.5' MIN: 12.5')

FOUNDATION PLANTINGS:

REQUIRED: 200'-41'=159' X 25'=

FRONT FACE REQUIRED: 297 SF (2,475 SF X 12%) PROVIDED: LEFT FACE REQUIRED: 393 SF (3,275 SF X 12%) PROVIDED REAR FACE REQUIRED: 297 SF (2,475 SF X 12%) PROVIDED: RIGHT FACE REQUIRED: 393 SF (3,275 SF X 12%) PROVIDED:

EXISTING SEWER AND WATER DEMAND:= o GPD

PROPOSED SEWER AND WATER DEMAND: FIXTURES @ 25 GAL/EMPLOYEE/SHIFT = 1,250 GPD

ESTIMATED TRIP GENERATION: (Per Trip Generation Manual, 10th Edition: 16,000 SF OFFICE (ITE CODE 710) **DAILY: 132** AM PEAK: 24 PM PEAK: 18

. PRIOR TO ANY CLEARING, GRADING OR CONSTRUCTION ACTIVITY, TREE PROTECTION FENCING WILL BE INSTALLED AROUND PROTECTED TREES OR GROVES OF TREES. NO CONSTRUCTION WORKERS, TOOLS, MATERIALS OR VEHICLES ARE PERMITTED WITHIN THE TREE PROTECTION

2. THE AREAS WITHIN THE TRIANGULAR SIGHT DISTANCE SHALL BE MAINTAINED FREE OF ALL OBSTRUCTIONS BETWEEN 30" AND 10' 3. A RAIN/FREEZE SENSOR SHALL BE USED IF THERE IS AN IRRIGATION SENSOR. 4. ALL PLANT BEDS ARE TO RECEIVE 3-4" OF PINESTRAW OR MULCH. 5. LANDSCAPING SHALL BE COMPLETE BEFORE ISSUANCE OF A CO.

SHADING REQUIREMNTS: $27,345 \text{ SF} \times .20 = 5,468 \text{ SF OF INTERIOR SHADING REQ'D.}$ 10 TREES \times 353 SF = 3530 SF SHADING 6 TREES $\times 707$ SF = 4242 SF SHADING TOTAL SHADING: 7,772 SF

	LEGEND					
	COMMON NAME	QTY	SIZE	HEIGHT	QTY	
FL	OWER, PERENNIAL				REQ'D	
	LIRIOPE, BIG BLUE	52	I GAL.	N/A	Φ	_
SH	RUB					
K/3	BOXWOOD, WINTERGREEN	62	3 GAL.	12"	62	_
W 11			3 GAL.		Φ	-
	CAMELLIA SASANQUA YULETIDE	2	7 GAL.	12"	2	
	LIGUSTRUM RECURVE	23	7 GAL.	3'	23	LOW BUFFER
.4664	MISCANTHUS ADAGIO		3 GAL.		52	
	HOLLY, SKY PENCIL		7 GAL.		0	
M	HOLLY, YAUPON, DWARF		3 GAL.	_	Ø	
	DRIFT ROSE		3 GAL.		ϕ	
\\\\\\\\\\\\\\\\\\\\\\\\\\\\\\\\\\\\\\	BREEZE GRASS		3 GAL.	-	ϕ	
	YEW, PRINGLES		3 GAL.		22	
	YEW, UPRIGHT JAPANESE		7 GAL.		23	
***	YUCCA, COLORGUARD		3 GAL.		Ø	
TR	REE					
0	TRIDENT MAPLE	11	2" CAL.		11	CANOPY
0	ALLEE ELM	4	2" CAL.		4	CANOPY
\odot	EAGLESTON HOLLY, TREE FORM	1		8'	1	UNDERSTORY
0	BALD CYPRESS	7	2" CAL.		7	CANOPY
0	SHUMARD OAK	4	2" CAL.		4	CANOPY

LANDSCAPE, INC. Landscape Installation Professionals JIM@FREEMANLANDSCAPE.COM

910-796-1166

Revision #: 1

Date: 2/3/2021

Scale:

1" = 30'

Landscape Plan:

240 Racine Dr. Office Bldg.

Landscape Design by: Jim Freeman - NCLC# 0071 Freeman Landscape, Inc.

Outdoor Lighting
Shoebox LED

The energy-efficient Shoebox LED combines a decorative, contemporary style with versatility and ample lighting effect that is perfect for streets, parking lots, commercial buildings and residential communities. The Shoebox LED provides excellent color rendition along with a controlled light pattern that reduces glare and keeps the light directed only where you want it. Available in black, dark bronze, gray or white with one to four

LED 150, 220, 420, 530 watts (Light Emitting Diode)

Mounting heights 25', 30', 35'

Black
Bronze
Gray
White

Fiberglass (1 or 2 fixtures per pole)
Decorative tapered metal

Decorative square metal

Note: 35' pole available in black or bronze only.

For additional information, visit us at duke-energy.com/OutdoorLighting or call us toll free at 866.769.6417.

DUKE ENERGY_® PROGRESS

BUILDING A SMARTER ENERGY FUTURE ®

Outdoor Lighting

Shoebox LED

Light source: LED (white)

Replacement for:* LED Wattage 150

Replacement for:* LED Wattage 150 – 250-watt HPS and metal halide;

LED Wattage 205 – up to 400-watt metal halide;

LED Wattage 530 – 1,000-watt metal halide

Warm-up and restrike time: Instant on (no warm-up or restrike time)

Warm-up and restrike time: Instant on (no warm-up or restrike time)						
Wattage	BUG Rating	Light Pattern	Lumens	Color Temp		
LED 150	B5-U0-G3	IESNA Type V (circular)	19580			
LED 150	B3-U0-G4	IESNA Type IV (forward throw)	18459			
LED 150	B2-U0-G3	IESNA Type III (oval)	19006			
LED 220	B5-U0-G3	IESNA Type V (circular)	25870			
LED 220	B3-U0-G4	IESNA Type IV (forward throw)	24390	4 0001/		
LED 220	B2-U0-G4	IESNA Type III (oval)	25114	4,000K		
LED 420	B5-U0-G5	IESNA Type V (circular)	48514			
LED 420	B3-U0-G5	IESNA Type IV (forward throw)	43765			
LED 530	B5-U0-G5	IESNA Type V (circular)	60296			

Type III

light distribution pattern

* These are approximate replacement suggestions; actual conditions could be different.

LED 530 B3-U0-G5 IESNA Type IV (forward throw) 54395

Poles available:	Mounting height	Color		
Round tapered decorative metal*	35'	Black Bronze		
Decorative square metal*	25' and <mark>30'</mark>	Black Gray Bronze White		
Fiberglass 30'		Black (1 or 2 fixtures per pole) Gray (1 or 2 fixtures per pole)		
Features		Benefits		
Little or no installation cost		Frees up capital for other projects		
Design services by lighting professionals	included	Meets industry standards and lighting ordinances		
Maintenance included		Eliminates high and unexpected repair bills		
Electricity included		Less expensive than metered service		
Warranty included		Worry-free		
One low monthly cost on your electric bill		Convenience and savings for you		
Turnkey operation		Provides hassle-free installation and service		
Backed by over 40 years of experience		A name you can trust today and tomorrow		

*2' raised foundation available when required on metal poles only.

©2019 Duke Energy Corporation 193519 12/19

LIGHTING DESIGN TOLERANCE

The calculated footcandle light levels in this lighting design are predicted values and are based on specific information that has been supplied to Duke Energy Progress. Any inaccuracies in the supplied information, differences in luminaire installation, lighted area geometry including elevation differences, reflective properties of surrounding surfaces, obstructions (foliage or otherwise) in the lighted area, or lighting from sources other than listed in this design may produce different results from the predicted values. Normal tolerances of voltage, lamp output, and ballast and luminaire manufacture will also affect results.


DISTANCE CALIBRATION (INCHES)



†0.0 †0.0 †0.1 †0.1 †0.2 †0.2 †0.2 †0.2 †0.1 †0.1 †0.1 †0.1 †0.1 †0.1 †0.2 †0.2 †0.3 †0.3 †0.3 $^{+}0.4$ $^{+}0.5$ $^{+}0.6$ $^{+}0.6$ $^{+}0.3$ $^{+}0.1$ $^{+}0.0$ $^{+}0.0$ $^{+}0.0$ $^{+}0.0$ $^{+}0.0$ $^{+}0.0$ 0.0 0.0 0.0 0.0 0.0 $^{\dagger}0.0$ $^{\dagger}0.0$ $^{\dagger}0.0$ $^{\dagger}0.0$ $^{\dagger}0.0$ $^{\dagger}0.0$ $^{\dagger}0.1$ $^{\dagger}0.1$ $^{\dagger}0.1$ $^{\dagger}0.1$ $^{\dagger}0.2$ $^{\dagger}0.8$ $^{\dagger}1.0$ $^{\dagger}1.0$ $^{\dagger}0.8$ $^{\dagger}0.8$ $^{\dagger}0.6$ $^{\dagger}0.4$ $^{\dagger}0.3$ $^{\dagger}0.3$ $^{\dagger}0.3$ $^{\dagger}0.4$ $^{\dagger}0.7$ $^{\dagger}1.5$ $^{\dagger}1.5$ $^{\dagger}1.5$ $^{\dagger}1.5$ $^{\dagger}0.9$ $^{\dagger}0.3$ $^{\dagger}0.1$ $^{\dagger}0.1$ $^{\dagger}0.1$ $^{\dagger}0.1$ $^{\dagger}0.0$ $^{\dagger}0.0$ $^{\dagger}0.0$ $^{\dagger}0.0$ 0.5 0.5 0.5 0.7 1.0 1.4 29 3.8 5.1 *5.7 4.3 3.3 *2.9 *2.7 *3.0 3.1.7 219 EV 5 *3.0 43.0 3.5 4 3 *4.7 2.6 *3.1 *4.6 *5.3 4.1 *3.2 *3.0 *3.1 *3.5 *4.9 *\frac{1}{2}.0 \frac{1}{2}.0 \frac{1}.0 \frac{1}{2}.0 \frac{1}{2}.0 \frac{1}{2}.0 \frac{1}{2}.0 \fra /o.0 | 0.0 | 0.0 | o.0 | o.0 | o.1 | o.1 | D. 1 0.7 2.3 2.7 2.4 2.1 1.7 1.2 70.7 0.4 0.3 0.3 0.5 0.7 0.9 1.0 1.2 1.4 21.1 2 1.5 0.1 0.1 †0 25 †0 2 | 10.7 | 2.4 *2.5 *2.3 *2.0 *1.6 ‡1.2 †0.7 †0.4 †0.3 †0.3 †0.4 †0.7 †1.0 ‡1.2 †1.3 *1.5 **£**1.3 ***1.5 £**1.3 **£1.3 £1.3** ↑0.0 ↑0.0 ↑0.0 ↑0.1 ↑0.1 ↑0.1 ↑0.1 ↑0.2 ↑0 3 ↑0 |4 ↑0.8 ↑2.6 ↑2.5 ↑2.5 ↑2.0 ↑1.5 ↑1.1 ↑0.4 ↑0.3 ↑0.4 ↑0.7 ↑1.1 ↑1.4 ↑1.5 ***1.8 *1.7 № 9** ↑0.2 **↑0 1** ↑0.1 ↑0.1 ↑0.1 ↑0.0 ↑0.0 **//**0.0 †0 4 †0 6 *1.0 *2.5 *2.5 *3.0 *2.2 *1.5 *1.0 †0.7 †0.4 †0.3 †0.3 †0.5 †0.8 †1.2 †1.5 †1.7 1.4 0.3 0 3 0.2 00 NO DESTER 1 0.0 0.0 0.0 0.0 0.0 0.0 0.0 0.0 0.0 0.0 0.0 0.0 0.0 0.0 0.0 0.0

PROPRIETARY & CONFIDENTIAL

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Statistics						
Description	Symbol	Avg	Max	Min	Max/Min	Avg/Min
Grid	+	0.7 fc	5.7 fc	0.0 fc	N/A	N/A
Parking	Ж	2.5 fc	5.7 fc	0.5 fc	11.4:1	5.0:1

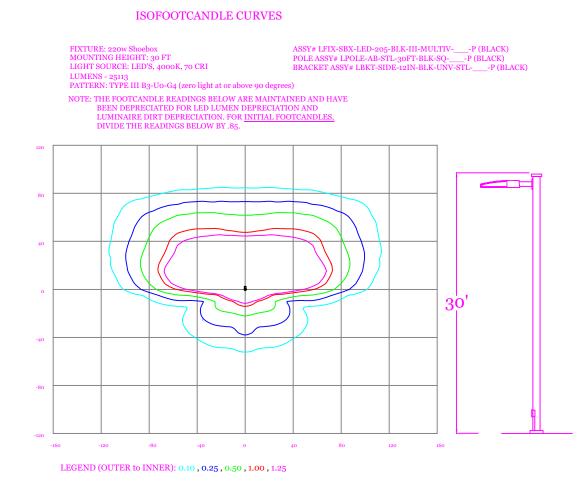Schedule						
Symbol	Label	QTY	Description	Number Lamps	Lumens per Lamp	LLF
Ĭ,	220w SB III	6	LED 220w Shoebox - Type III - 4000K	64	392	0.85

PROJECT #: 2020054 STORMWATER PERMIT #: 2021012

APPROVED CONSTRUCTION PLAN

DATED: 3/11/21

 240 RACINE DRIVE

 Wilmington, NC

 SITE LIGHTING PLAN

 Designed by DEP LIGHTING SOLUTIONS

 Reviewed by Date 11/24/2020
 N. Johnson Scale 1" = 20'

 Date 11/24/2020
 Size "Arch D"

 Description LED 220w Shoebox

 Drawing No.
 20-0400A
 Sht. 1 OF 1